This planning application is open for public comment until 20 October 2025

Reference no	PLN-25-0047
Site	924 DEDDINGTON ROAD DEDDINGTON
Proposed Development	Retrospective multiple dwelling and deck (vary access and parking provisions)
Zone	12.0 Village
Use class	Residential

Written representations may be made during this time to the General Manager; mailed to PO Box 156, Longford, Tasmania 7301, delivered to Council offices or a pdf letter emailed to planning@nmc.tas.gov.au

(no special form required)

PLANNING APPLICATION Exhibited



Proposal

Description of proposal:	As Constructed Dwelling and Dec	ck
(attach additional sheets if necessar		
If applying for a subdivision the road, in order of prefer	n which creates a new road, please sup Tence:	oply three proposed names for
1	2 3	
Site address: 924 Dedding	gton Road	
Deddington TAS 7212		
CT no: 248708/4		
CT no:		
Estimated cost of project		(include cost of landscaping, arks etc for commercial/industrial uses)
, -	lings on this property? Yes asDwelling	
If variation to Planning Scho	eme provisions requested, justificatior	n to be provided:
(attach additional sheets if necessar	y)	
1		
is any signage required?	(if ves. provide	





FOLIO PLAN

RECORDER OF TITLES



Issued Pursuant to the Land Titles Act 1980

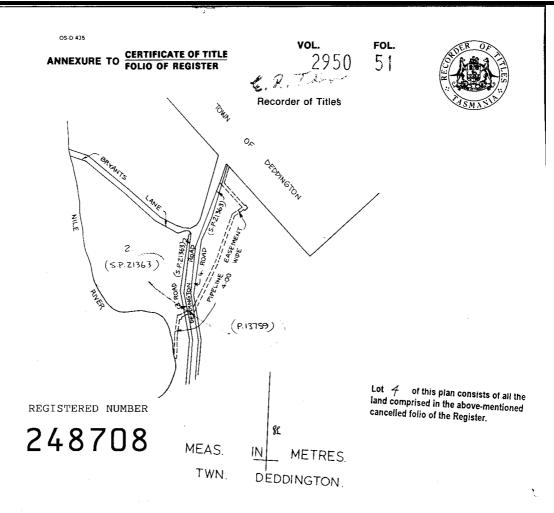

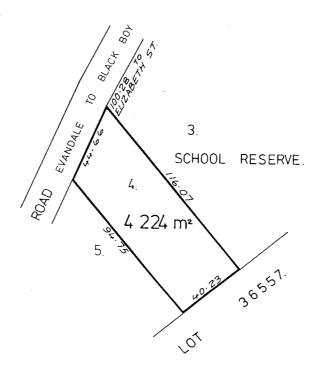

Search Date: 14 Mar 2025

Search Time: 02:14 PM

Volume Number: 248708

Revision Number: 01

Page 1 of 1

Plumbing Report – Septic Tank Installation / System **Details**

Property Information

Address: 924 Deddington Road, Deddington, TAS 7212

Council: Northern Midlands Council

Property ID (PID): 6399091

· Zoning: Rural Residential

New Plumbing System – Septic Tank Details

1. Tank Location & Pipework

· Tank Position:

The 4000 L Everhard septic tank is installed 15 metres downslope from the main dwelling, in a location that allows for gravity-fed flow and vehicle access for pumpout.

· Pipe Gradient / Fall:

The sewage line from the main house to the septic tank is approximately 15 metres in length, with an approximate fall of 1:60 (i.e. 250 mm over 15 m) to maintain adequate self-cleansing velocity as per AS/NZS 3500.2.

2. Tank Type & Capacity

Tank Brand: Everhard

· Tank Size: 4000 L (Heavy-Duty Polyethylene)

· Lid Type: Trafficable

• Inlet/Outlet: 100 mm PVC DWV pipe with inspection access

- Ventilation: Provided via high point vent downstream of fixture traps and at the tank outlet
- Access: Via vehicle for pump-out

a Occupancy & Capacity

Structure Max Occupants Fixtures Connected Flow Estimate Main House 6 people Kitchen, laundry, 1 bathroom, WC~900–1,200 L/day ~250-400 L/day Studio / Cabin 2 people Bathroom, kitchenette 8 people Full household plumbing ~1,200–1,600 L/day Total

Total design capacity: 8 occupants

AS/NZS 1547 Guideline: 4000 L septic tank is adequate for up


to 10 equivalent persons under normal use.




🥽 Drainage / Effluent Disposal

- Type: Septic tank with gravity discharge to subsurface absorption trenches
- · Disposal Field: Located downslope of tank, in non-traffic, well-drained soil area
- · Setbacks:
 - 6 m from dwelling
 - 3 m from boundaries
 - _o 30 m from any watercourse
- Soil Type: Well-drained loam over clay base.

Site Sketch / Map (not to scale)

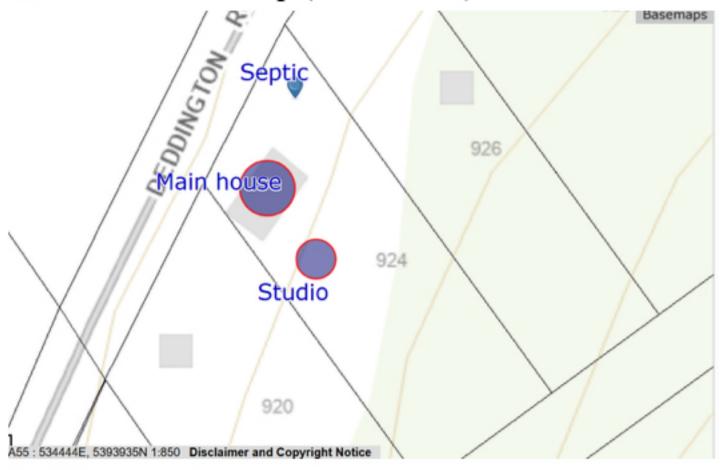

Deddington Road

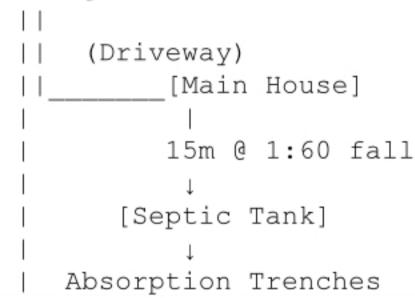

☑ Compliance & Notes

- Septic tank and disposal field are sized and located in accordance with AS/NZS 1547:2012
- Installation performed by licensed plumbing contractor
- Inspection openings, access lids, and venting installed per Tasmanian Plumbing Code
- · Adequate fall ensures free drainage from both dwellings
- System is accessible for maintenance and pump-out vehicles



DRAWING SCHEDULE

A00	COVER PAGE
A01	SITE PLAN
A02	CONSTRUCTION PLAN - AS CONSTRUCTED DWELLIN
A03	CONSTRUCTION PLAN - AS CONSTRUCTED PERGOLA
A04	FLOOR PLAN - AS CONSTRUCTED DWELLING
A05	ROOF PLAN
A06	ELEVATIONS #1
A07	ELEVATIONS #2
A08	3D PERSPECTIVE #1
A09	3D PERSPECTIVE #2
A10	3D PERSPECTIVE #3
A11	3D PERSPECTIVE #4

PROJECT INFORMATION

BUILDING DESIGNER:	GRANT JAMES PFEIFFER
ACCREDITATION No:	CC2211T
ZONE:	12.0 VILLAGE
BUILDING CLASS:	CLASS 1A
LAND TITLE REFERENCE NUMBER:	248708/4
DESIGN WIND SPEED:	ASSUMED 'N3'
SOIL CLASSIFICATION:	ASSUMED 'H1'
CLIMATE ZONE:	7
BUSHFIRE-PRONE BAL RATING:	N/A
ALPINE AREA:	N/A
CORROSION ENVIRONMENT:	NO
FLOODING:	NO
LANDSLIP:	LOW
DISPERSIVE SOILS:	UNKNOWN
SALINE SOILS:	UNKNOWN
SAND DUNES:	NO
MINE SUBSIDENCE:	NO
LANDFILL:	NO
GROUND LEVELS:	REFER PLAN
ORG LEVEL:	75mm ABOVE GROUND LEVEL

AS CONSTRUCTED STUDIO


S . BRIEN 924 DEDDINGTON ROAD, DEDDINGTON TAS 7212


NORTHERN MIDLANDS COUNCIL

ISSUED FOR APPROVAL

DEVELOPMENT AREA			
Name Area			
AS CONSTRUCTED PERGOLA	27.78 m²		
AS CONSTRUCTED STUDIO	71.33 m²		
DECK	14.80 m²		
EXISTING FRONT SHED	28.34 m²		

142.25 m²

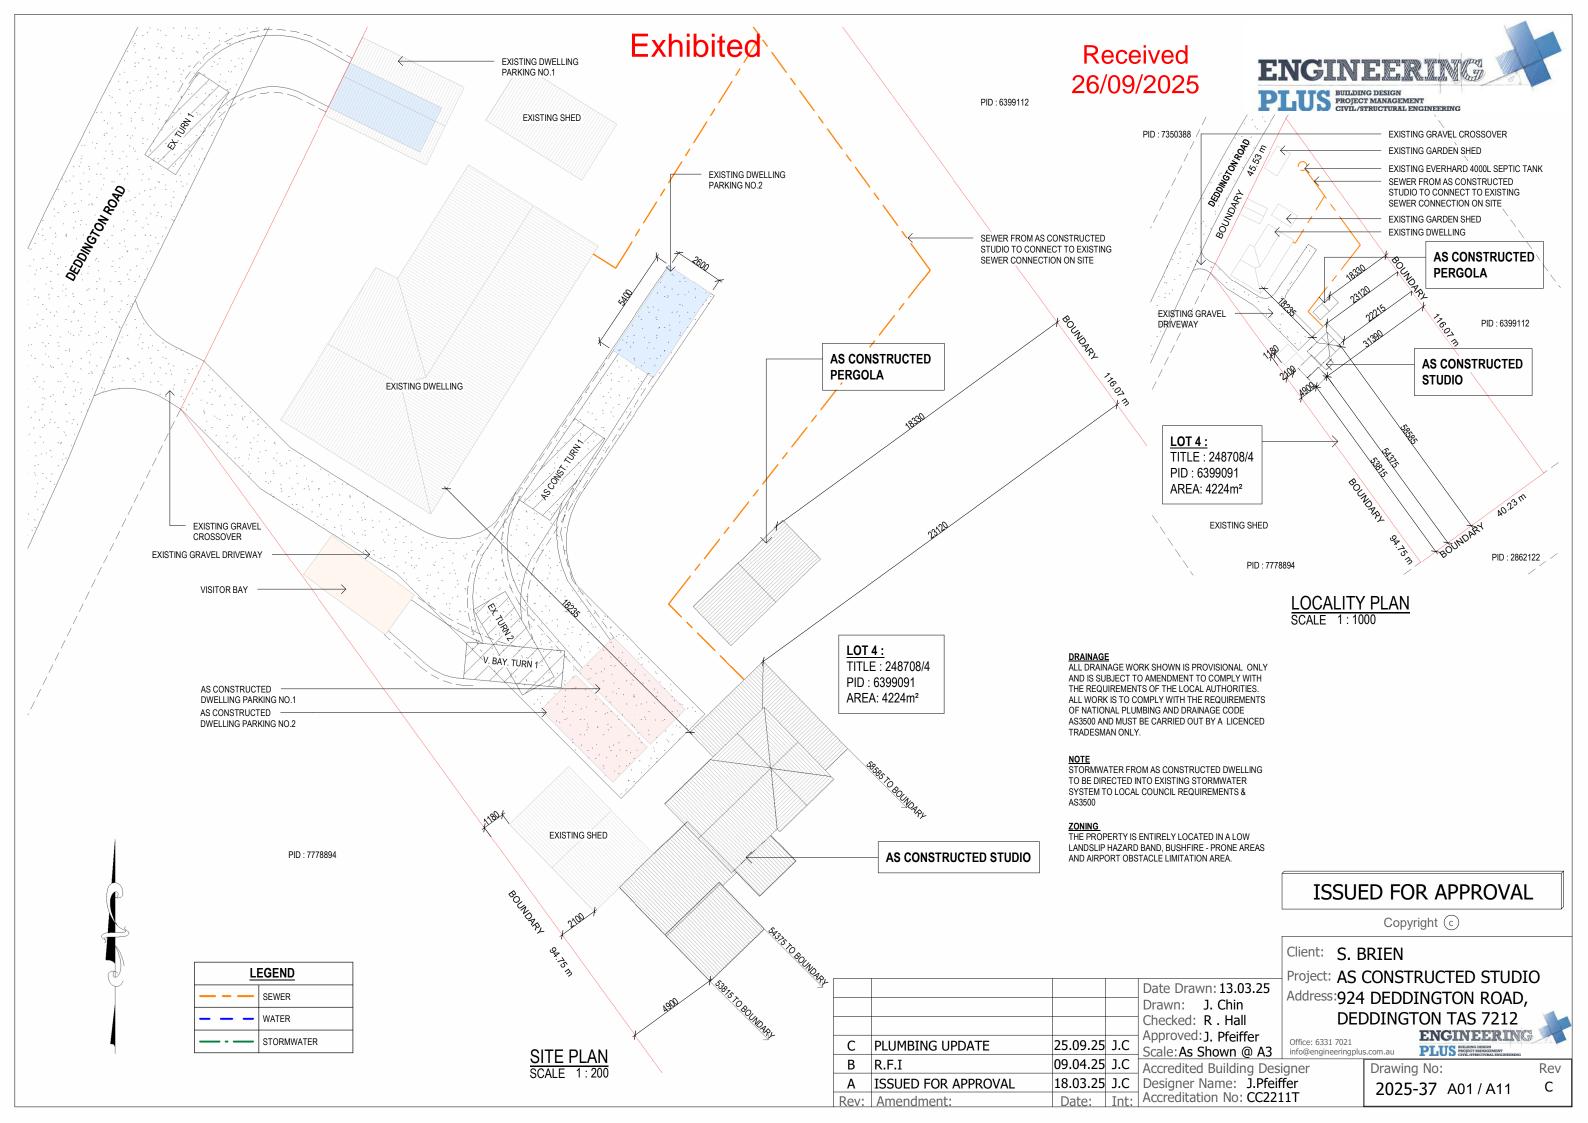

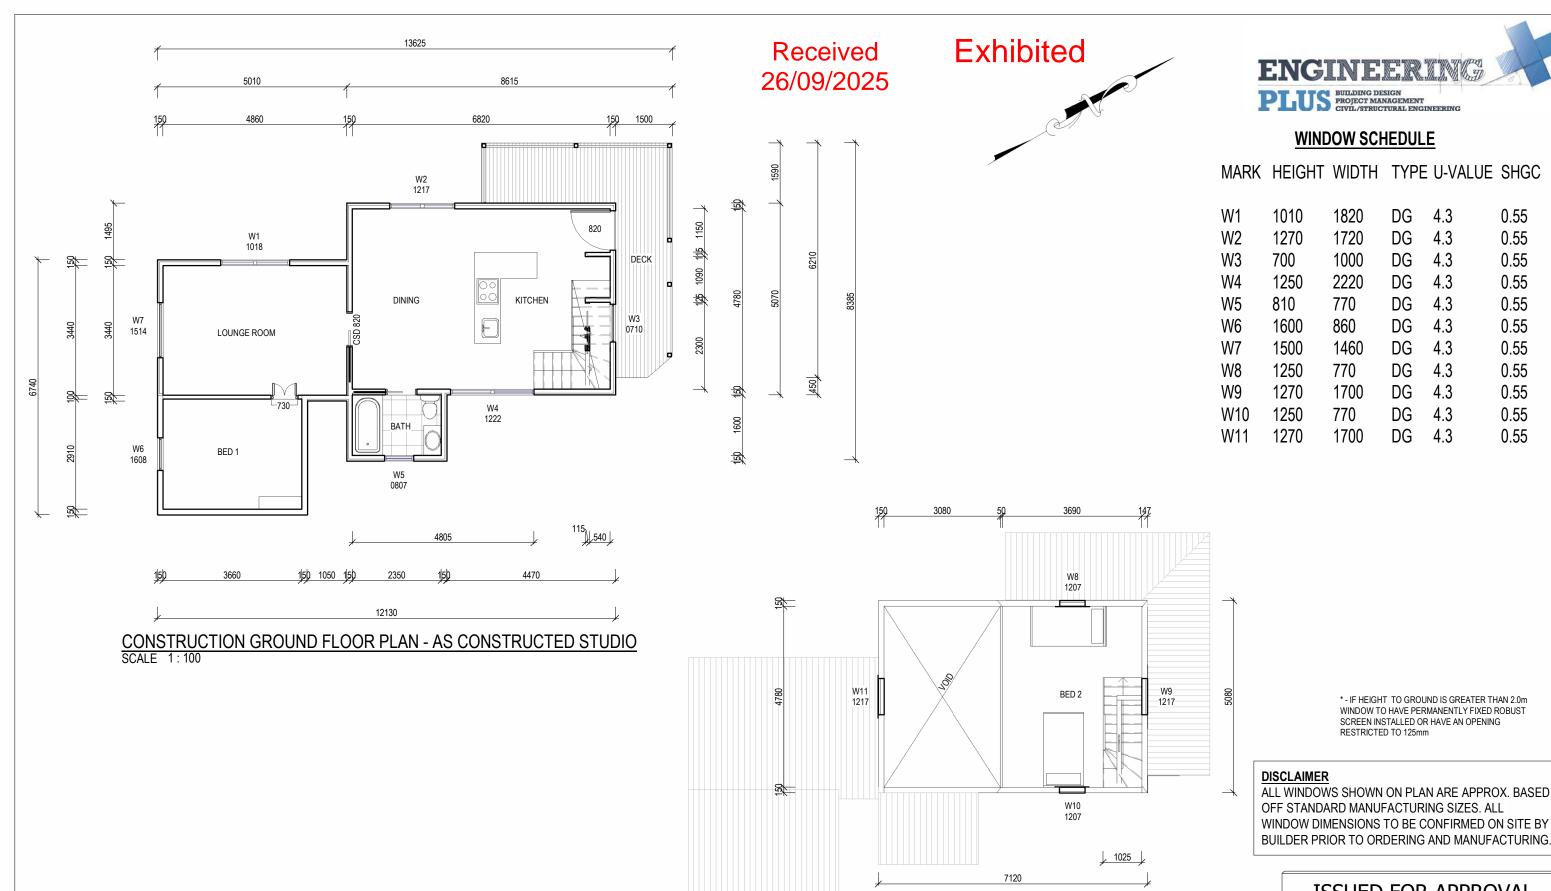

CONSTRUCTION FIRST FLOOR PLAN - AS CONSTRUCTED STUDIO SCALE 1:100

					Proje
				Date Drawn: 13.03.25	Addr
				Drawn: J. Chin	Addi
				Checked: R . Hall	
	PLUMBING UPDATE	25.09.25	1.0	Approved: J. Pfeiffer	Office:
				Scale: As Shown @ A3	info@e
В	R.F.I	09.04.25	J.C	Accredited Building Desi	igner
Α	ISSUED FOR APPROVAL	18.03.25	J.C	Designer Name: J.Pfeif	fer
Rev:	Amendment:	Date:	Int:	Accreditation No: CC221	l1T

* - IF HEIGHT TO GROUND IS GREATER THAN 2.0m WINDOW TO HAVE PERMANENTLY FIXED ROBUST SCREEN INSTALLED OR HAVE AN OPENING

ISSUED FOR APPROVAL

Copyright ©

Client: S. BRIEN

S BUILDING DESIGN
PROJECT MANAGEMENT
CIVIL/STRUCTURAL ENGI

1820

1720

1000

2220

770

860

1460

770

770

1700

1700

DG

4.3

4.3

0.55

0.55

Project: AS CONSTRUCTED STUDIO

Address: 924 DEDDINGTON ROAD, **DEDDINGTON TAS 7212**

Office: 6331 7021

ENGINEERING

Rev

С

PLUS BUILDING DESIGN
PROJECT MANAGEMENT
CIVIL/STRUCTURAL ENGI

Drawing No:

2025-37 A02 / A11

14.80 m² 28.34 m² 3.05 142.25 m² 15.31

Area

27.78 m²

71.33 m²

Area (sq)

2.99

7.68

1.59

Area Schedule (Gross Building)

Name


AS CONSTRUCTED PERGOLA

AS CONSTRUCTED STUDIO

EXISTING FRONT SHED





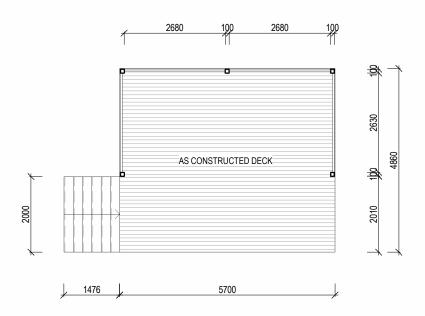

CONSTRUCTION GROUND FLOOR PLAN - AS CONSTRUCTED PERGOLA SCALE 1:100

C PLUMBING UPDATE

A ISSUED FOR APPROVAL

R.F.I

Rev: Amendment:

ISSUED FOR APPROVAL

Copyright ©

Client: S. BRIEN

Project: AS CONSTRUCTED STUDIO Date Drawn: 13.03.25

Address:924 DEDDINGTON ROAD, **DEDDINGTON TAS 7212**

ENGINEERING PLUS BUILDING DESIGN
PROJECT MANAGEMENT
GIVIL/STRUCTURAL ENGIS

Rev

С

Approved: J. Pfeiffer Scale: As Shown @ A3 Office: 6331 7021 info@engineeringplus.com.au 09.04.25 J.C Accredited Building Designer Drawing No: 18.03.25 J.C Designer Name: J.Pfeiffer Accreditation No: CC2211T

Drawn: J. Chin

Checked: R . Hall

25.09.25 J.C


2025-37 A03 / A11







GROUND FLOOR PLAN - AS CONSTRUCTED STUDIO SCALE 1:100

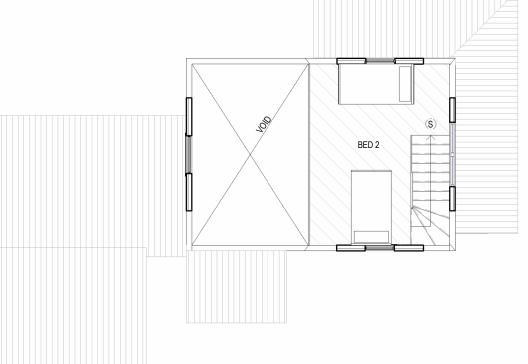

FLOOR COVERINGS CARPET CONCRETE TIMBER DECKING TILE VINYL TIMBER FLOORING

SMOKE ALARMS
PROVIDE AND INSTALL SMOKE ALARMS & HARD WIRE
TO BUILDING POWER SUPPLY TO AS 3786.
CEILING MOUNTED WITH 9VDC ALKALINE BATTERY BACKUP TO LOCATIONS INDICATED ON PLAN AND IN ACCORDANCE WITH ABCB OF H3D6 - PART 9.5.2

(\$) - DENOTES INTERCONNECTED SMOKE DETECTORS

FIRST FLOOR PLAN - AS CONSTRUCTED STUDIO SCALE 1:100

Area Schedule (Gross Building)					
Name Area Area (sq)					
AS CONSTRUCTED PERGOLA	27.78 m ²	2.99			
AS CONSTRUCTED STUDIO	71.33 m ²	7.68			
DECK	14.80 m²	1.59			
EXISTING FRONT SHED	28.34 m²	3.05			
142.25 m ² 15.31					

					Proje
				Date Drawn: 13.03.25	Addr
				Drawn: J. Chin	Addir
				Checked: R . Hall	
С	PLUMBING UPDATE	25.09.25	J.C	Approved: J. Pfeiffer Scale: As Shown @ A3	Office:
В	R.F.I	09.04.25	J.C	Accredited Building Desi	ianer
Α	ISSUED FOR APPROVAL	18.03.25	J.C	Designer Name: J.Pfeif	fer
Rev:	Amendment:	Date:	Int:	Accreditation No: CC221	l1T

ISSUED FOR APPROVAL

Copyright ©

Client: S. BRIEN

Project: AS CONSTRUCTED STUDIO

Address: 924 DEDDINGTON ROAD, **DEDDINGTON TAS 7212**

Office: 6331 7021

ENGINEERING

PLUS BUILDING DESIGN
PROJECT MANAGEMENT
CIVIL/STRUCTURAL ENGIN info@engineeringplus.com.au

Drawing No:

2025-37 A04 / A11

С

Rev







COLORBOND 'CUSTOM ORB' METAL SHEETING INSTALLED IN ACCORDANCE WITH THIS PART, AS 1562.1 AND MANUFACTURERS RECOMMENDATIONS.

REFER TO LYSAGHT ROOFING & WALLING MANUAL FOR FULL DETAILS ON SHEET INSTALLATION, FIXINGS & FLASHINGS

COLORBOND 'CUSTOM ORB'

- MINIMUM PITCH 5 DEGREES.
- CORROSION PROTECTION IN ACCORDANCE WITH BCA TABLE 3.5.1.1.
- END LAP OF SHEETS

5-15 DEGREES - MINIMUM 200MM.


ABOVE 15 DEGREES - MINIMUM 150 MM.


- RIDGE LINE VALLEY TO BE TURNED UP (STOP ENDED).
- FASTENERS TO BE MADE OF COMPATIBLE MATERIAL WITH ROOFING MATERIAL.
- CREST FIXINGS OF END SPANS @ EVERY SECOND RIB AND INTERNAL SPANS @ EVERY THIRD RIB.
- WHERE POSSIBLE SHEETS TO BE LAID WITH SIDE LAPS FACING AWAY FROM PREVAILING WEATHER.
- REFLECTIVE FOIL INSULATION TO BE FITTED TO UNDERSIDE OF SHEETS.

R4.0 INSULATION BATTS TO ROOF SPACE ABOVE CEILING LINING.

RECOMMENDED FIXINGS FOR SEVERE EXPOSURE CONDITIONS TO AS 3566

USE CLASS 4 MATERIALS FOR SEVERE EXPOSURE & STAINLESS STEEL FOR VERY SEVERE COASTAL ENVIRONMENTS.

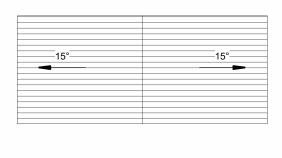

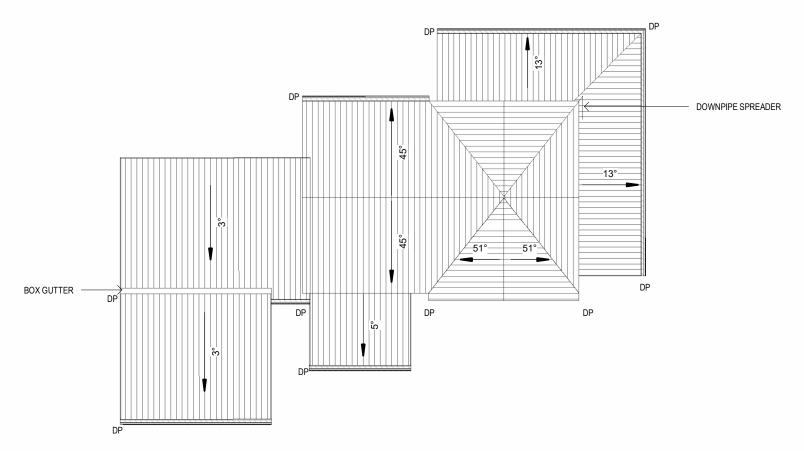

ROOF PLAN SCALE 1:100

DOWNPIPES - NCC PART 7.4

MAX. 12M GUTTER LENGTH PER DOWNPIPE LOCATED AS CLOSE AS POSSIBLE TO VALLEY GUTTERS SELECTED IN ACCORDANCE WITH TABLES 7.4.4a TO 7.4.4c

OVERFLOW MEASURES

IN ACCORDANCE WITH 7.4.7 AND TABLE 7.4.4a & 7.4.4b AND FIG. 7.4.7a TO 7.4.7d END STOP WEIR

100mm MIN CLEAR WIDTH. INSTALLED 25mm BELOW FASCIA TOP NOT SUITABLE WHEN END-STOP ABUTS WALL

INVERTED NOZZLE

INSTALLED WITHIN 500mm OF GUTTER HIGH POINT 100x50mm MIN, NOZZLE SIZE - MIN, 25mm BELOW FASCIA TOP FRONT FACE WEIR

200mm CLEAR WIDTH - 20mm CLEAR HEIGHT INSTALLED MIN. 25mm BELOW FASCIA TOP

75mm DIA HOLE IN OUTWARD FACE - CENTERLINE 100mm BELOW FASCIA TOP

GUTTERS - NCC PART 7.4

FALL NOT LESS THAN 1:500 SUPPORT BRACKETS FIXED AT STOP ENDS, CORNERS AND MAX. 1.2m CENTRES VALLEY GUTTERS TO BE DIMENSIONED IN ACCORDANCE WITH TABLE 7.4.4c HAVE A ROOF PITCH AND SIDE ANGLE OF NOT LESS THAN 12.5deg HAVE A MIN. FREEBOARD OF NOT LESS THAN 15mm

OVERFLOW MEASURES

IN ACCORDANCE WITH 7.4.6 AND TABLE 7.4.4a & 7.4.4b AND FIGURE 7.4.6a & 7.4.6b FRONT FACE SLOTTED GUTTER

MIN SLOT OPENING 1200mm/ GUTTER m

ONE PER BRACKET - MIN. 50mm WIDE

LOWER EDGE OF SLOT INSTALLED 25mm BELOW FASCIA TOP CONTROLLED BACK GAP

PERMANENT MIN. 10mm SPACER BETWEEN GUTTER & FASCIA

GUTTER INSTALLED MIN. 10mm BELOW FASCIA TOP

Rev: Amendment:

						Proje
					Date Drawn: 13.03.25	Addre
İ					Drawn: J. Chin	Addit
ŀ					Checked: R . Hall	
-					Approved: J. Pfeiffer	0.00
	С	PLUMBING UPDATE	25.09.25	J.C	Scale: As Shown @ A3	Office: (info@er
	В	R.F.I	09.04.25		Accredited Building Des	ianer
	Α	ISSUED FOR APPROVAL	18.03.25		Designer Name: J.Pfeif	

Date: Int: Accreditation No: CC2211T

ISSUED FOR APPROVAL

Copyright (c)

Client: S. BRIEN

Project: AS CONSTRUCTED STUDIO

Address: 924 DEDDINGTON ROAD, **DEDDINGTON TAS 7212**

Office: 6331 7021

ENGINEERING

PLUS BUILDING DESIGN
PROJECT MANAGEMENT
CIVIL/STRUCTURAL ENGI

Drawing No:

2025-37 A05 / A11

Rev

Received 26/09/2025

COLORBOND "CUSTOM ORB" ROOFING TO



SOFFIT / EAVE LINED WITH 'HARDIFLEX' CEMENT SHEETING

- TRIMMERS LOCATED WITHIN 1200 MM OF EXTERNAL CORNERS TO BE SPACED @ 500 MM CENTERS, REMAINDER OF SHEET 700 MM CENTERS
- FASTENER / FIXINGS WITHIN 1200 MM OF EXTERNAL CORNERS @ 200 MM CENTERS, REMAINDER OF SHEET 300 MM CENTERS


SELECTED ALUMINIUM FRAMED WINDOWS - ABCB VOLUME 2 PART 8.3

POWDER COATED ALUMINIUM WINDOW & DOOR FRAMES, UNLESS OTHERWISE NOTED.

TASMANIAN OAK REVEALS AND TRIMS. ALL FLASHING AND FIXINGS TO MANUFACTURERS SPECIFICATIONS.

GLAZING & FRAME CONSTRUCTION TO AS 2047 & AS 1288

ALL FIXINGS AND FLASHINGS TO MANUFACTURERS REQUIREMENTS

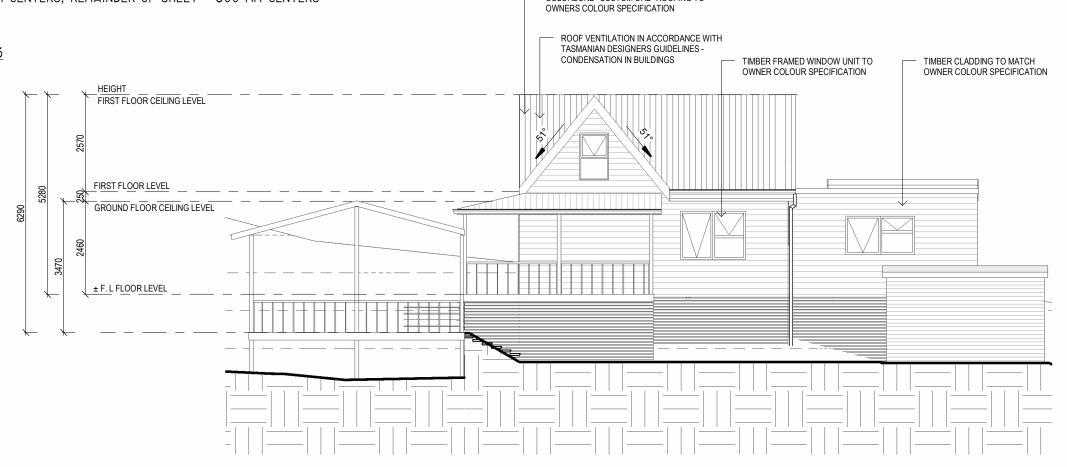


PLUMBING UPDATE

ISSUED FOR APPROVAL

R.F.I

Rev: Amendment:

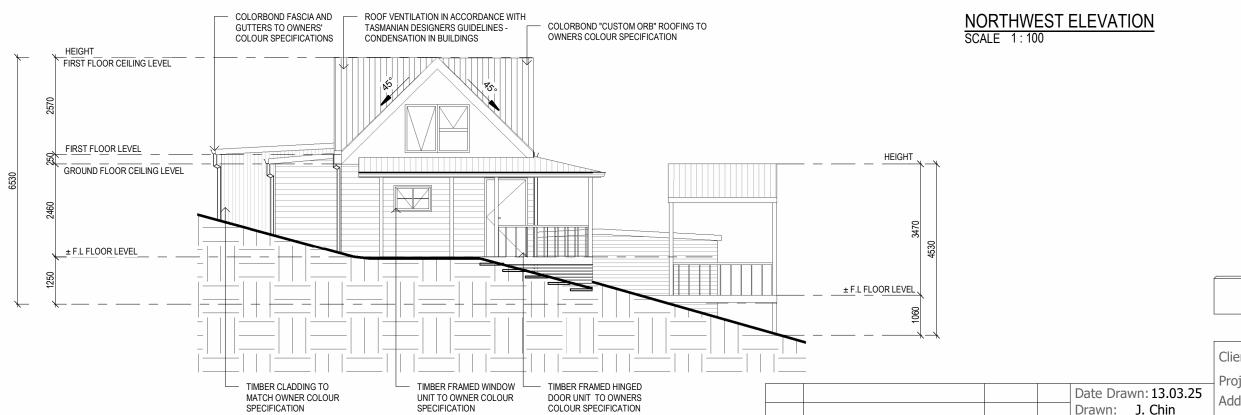

NORTHEAST ELEVATION

SCALE 1:100

ISSUED FOR APPROVAL

Copyright ©

Client: S. BRIEN

Project: AS CONSTRUCTED STUDIO

Address: 924 DEDDINGTON ROAD, **DEDDINGTON TAS 7212**

Checked: R. Hall

18.03.25 J.C Designer Name: J.Pfeiffer

Date: Int: Accreditation No: CC2211T

25.09.25 J.C

09.04.25 J.C

Approved: J. Pfeiffer

Scale: As Shown @ A3

ENGINEERING PLUS BUILDING DESIGN
PROJECT MANAGEMENT
CIVIL/STRUCTURAL ENGI

Accredited Building Designer

Drawing No:

2025-37 A06 / A11

Rev

SUB FLOOR VENTILATION. NCC VOL 2 PART 6.2.1


- A MINIMUM OF 150 MM OF SUB FLOOR CLEARANCE IS TO BE PROVIDED BETWEEN FINISHED SURFACE LEVEL & THE UNDERSIDE OF THE FLOOR BEARER.
- A MINIMUM OF 6000 MM2 PER METRE OF SUB FLOOR VENTILATION IS TO BE UNIFORMLY DISTRIBUTED AROUND THE EXTERNAL AND INTERNAL WALLS OF THE BUILDING.
- VENTS TO BE LOCATED NO GREATER THAN 600 MM FROM AN INTERNAL OR EXTERNAL CORNER.

PRYDA 230x75 - 52 HOLE VENT MAXIMUM SPACING 1050 MM ALONG WALL OR PRYDA 230x165 - 117 HOLE VENT MAXIMUM SPACING 2350 MM ALONG WALL


Exhibited

Received 26/09/2025



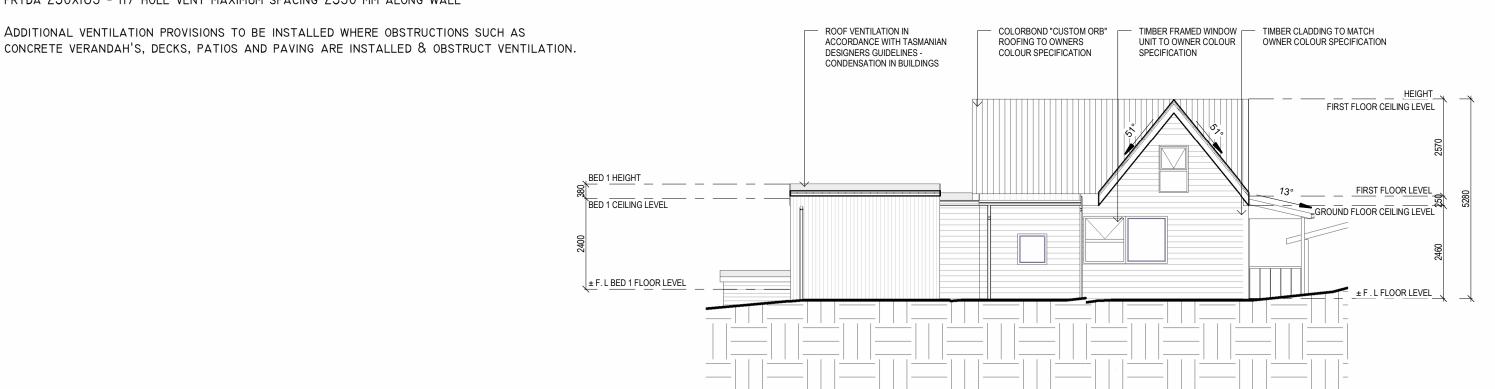

SOUTHEAST ELEVATION SCALE 1:100 ROOF VENTILATION IN ACCORDANCE WITH TIMBER CLADDING TO TIMBER FRAMED WINDOW COLORBOND "CUSTOM ORB" MATCH OWNER COLOUR UNIT TO OWNER COLOUR

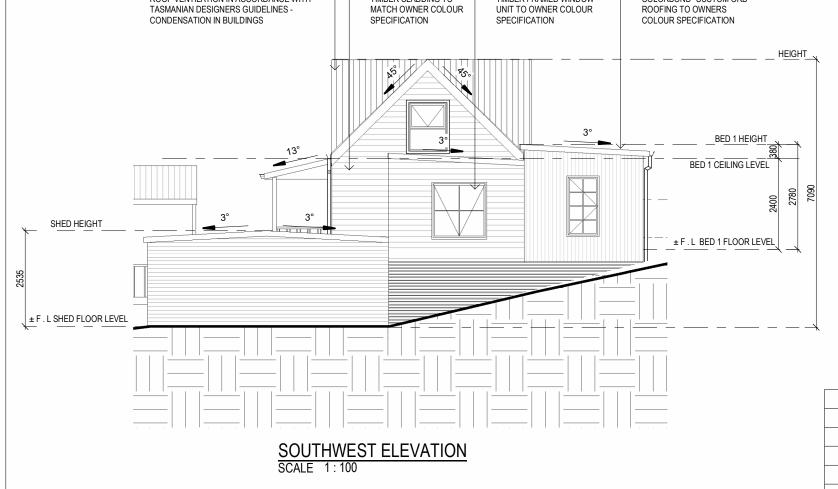

ISSUED FOR APPROVAL

Copyright ©

Client: S. BRIEN

Date Drawn: 13.03.25

Drawn: J. Chin

Checked: R. Hall

18.03.25 J.C Designer Name: J.Pfeiffer

Date: Int: Accreditation No: CC2211T

25.09.25 J.C

09.04.25 J.C

PLUMBING UPDATE

ISSUED FOR APPROVAL

R.F.I

Rev: Amendment:

Approved: J. Pfeiffer

Project: AS CONSTRUCTED STUDIO

Address: 924 DEDDINGTON ROAD, **DEDDINGTON TAS 7212**

ENGINEERING PLUS BUILDING DESIGN
PROJECT MANAGEMENT
CIVIL/STRUCTURAL ENGI

Scale: As Shown @ A3 Accredited Building Designer

Drawing No:

2025-37 A07/A11

Rev





C PLUMBING UPDATE

A ISSUED FOR APPROVAL

B R.F.I

Rev: Amendment:

ISSUED FOR APPROVAL

Copyright ©

Client: S. BRIEN

Project: AS CONSTRUCTED STUDIO

Address:924 DEDDINGTON ROAD, **DEDDINGTON TAS 7212**

ENGINEERING PLUS BUILDING DESIGN
PROJECT MANAGEMENT
GIVIL/STRUCTURAL ENGIS

Rev

С

Drawing No:

25.09.25 J.C Accredited Building Designer Designer Name: J.Pfeiffer Accreditation No: CC2211T


Date Drawn: 13.03.25

Drawn: J. Chin

Checked: R . Hall

2025-37 A08 / A11



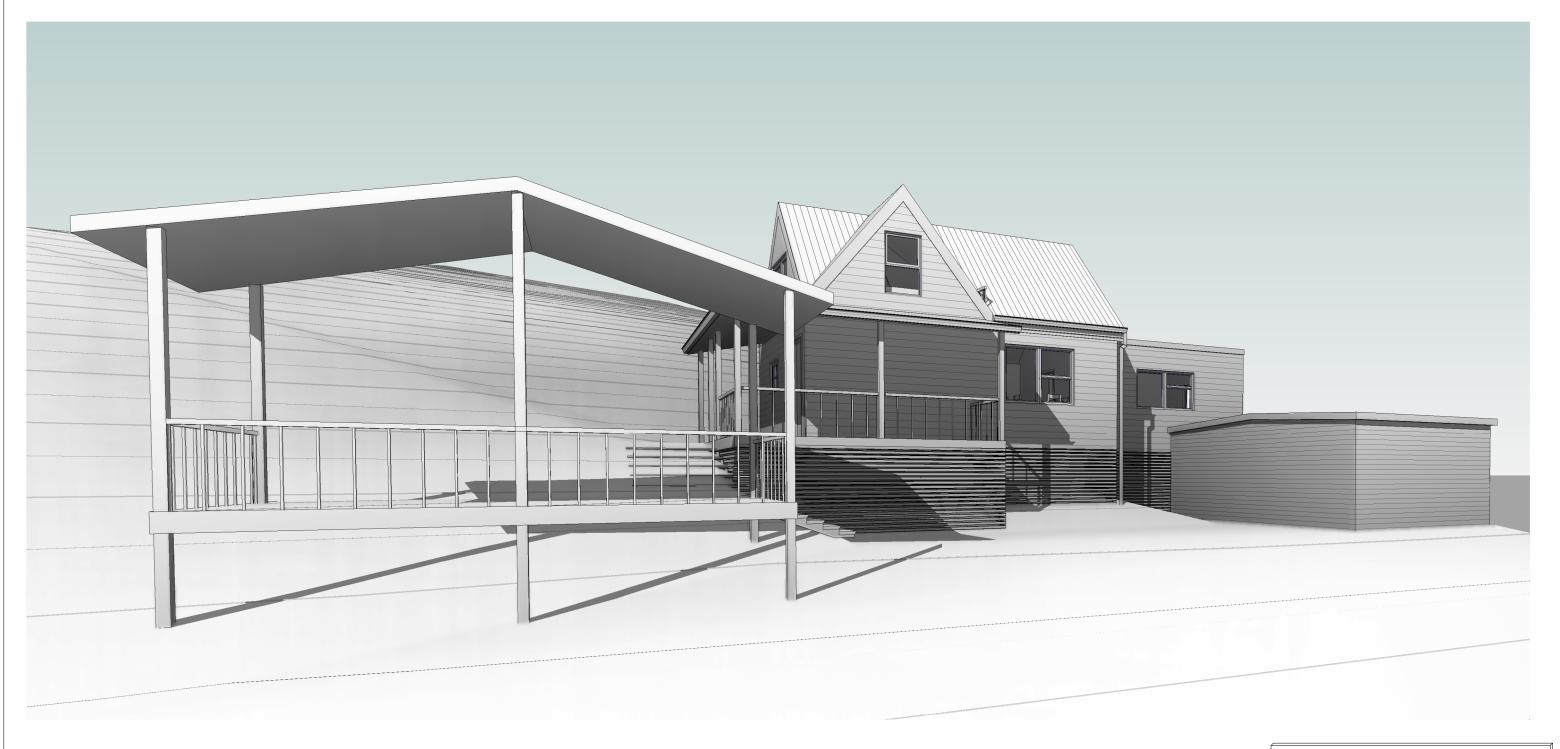

C PLUMBING UPDATE

A ISSUED FOR APPROVAL

B R.F.I

Rev: Amendment:

ISSUED FOR APPROVAL

Copyright ©

Client: S. BRIEN

Project: AS CONSTRUCTED STUDIO

Address:924 DEDDINGTON ROAD, **DEDDINGTON TAS 7212**

ENGINEERING

Rev

С

Date Drawn: 13.03.25


Drawn: J. Chin

Checked: R . Hall

25.09.25 J.C Accredited Building Designer Designer Name: J.Pfeiffer Accreditation No: CC2211T Drawing No:

2025-37 A09 / A11



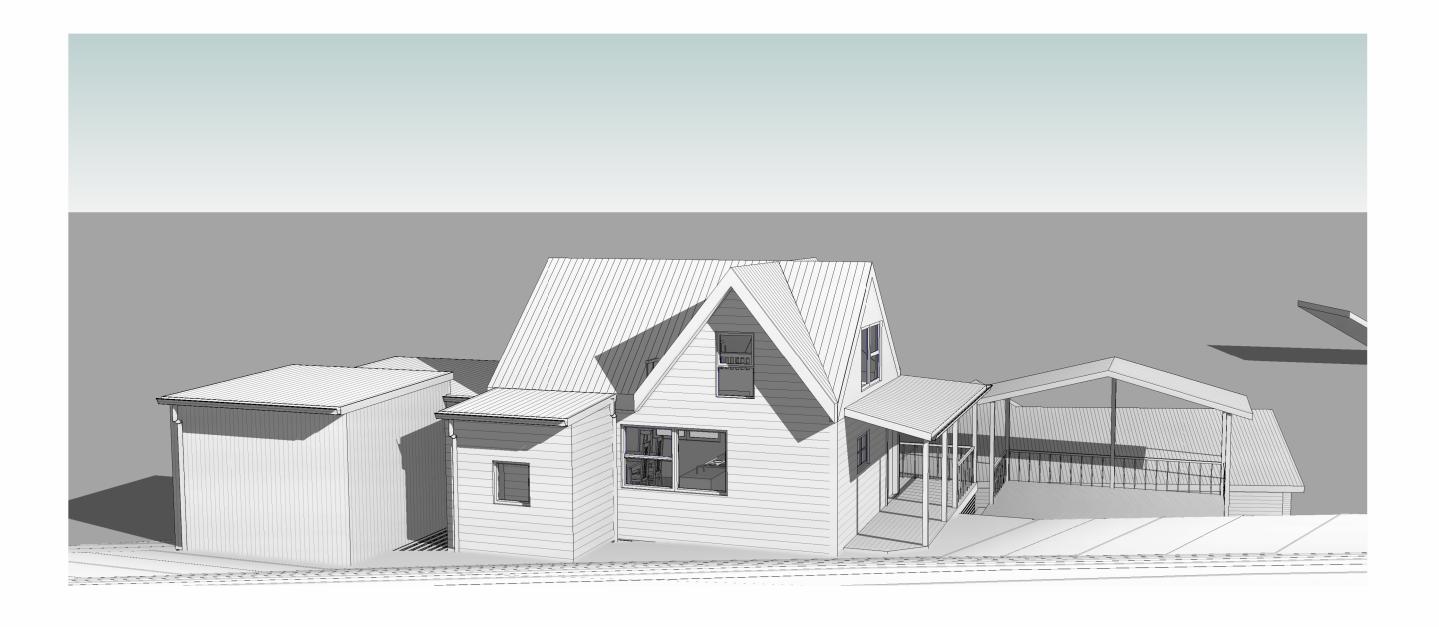

C PLUMBING UPDATE

A ISSUED FOR APPROVAL

R.F.I

Rev: Amendment:

ISSUED FOR APPROVAL

Copyright ©

Client: S. BRIEN

Project: AS CONSTRUCTED STUDIO

Address:924 DEDDINGTON ROAD, **DEDDINGTON TAS 7212**

ENGINEERING PLUS BUILDING DESIGN
PROJECT MANAGEMENT
GIVIL/STRUCTURAL ENGIS

Approved: J. Pfeiffer Scale: As Shown @ A3 Office: 6331 7021 info@engineeringplus.com.au 09.04.25 J.C Accredited Building Designer
18.03.25 J.C Designer Name: J.Pfeiffer
Accreditation No: CC2211T

Date Drawn: 13.03.25

Drawn: J. Chin


Checked: R . Hall

25.09.25 J.C

09.04.25 J.C

Drawing No: 2025-37 A10 / A11 Rev



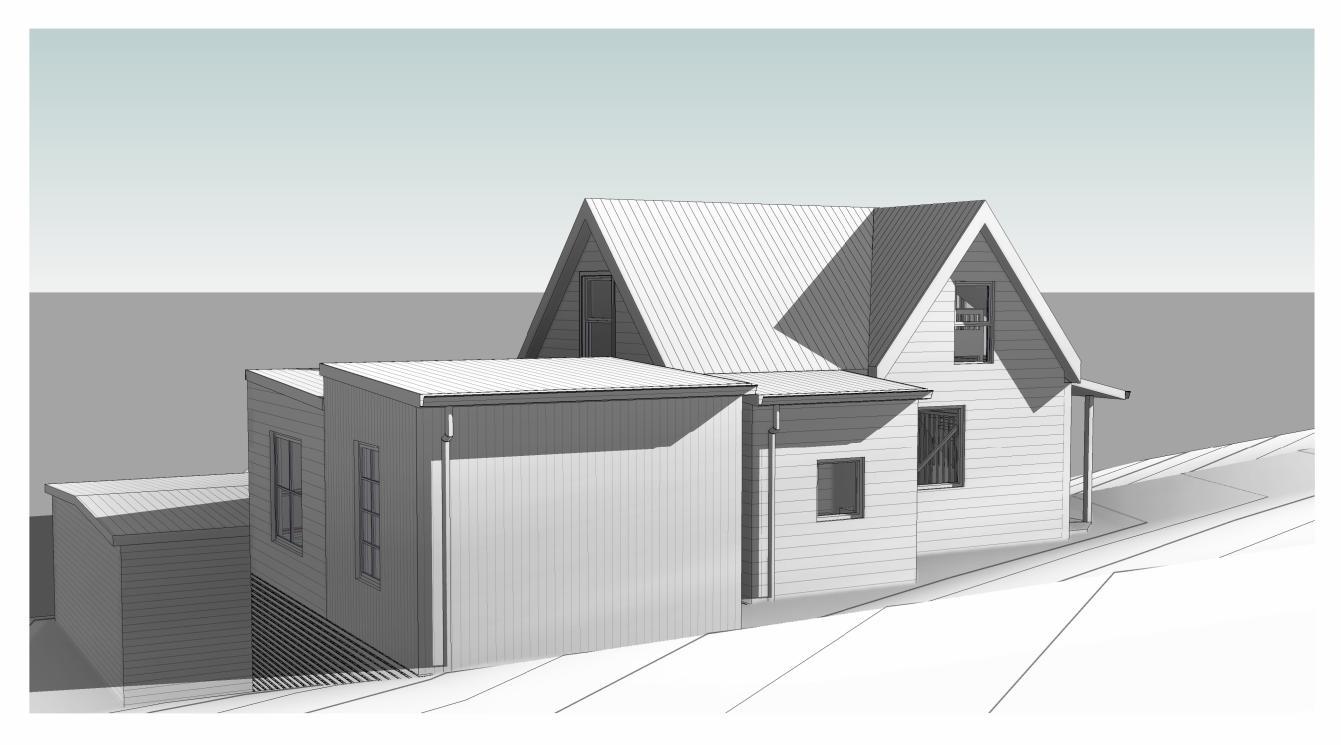

C PLUMBING UPDATE

A ISSUED FOR APPROVAL

B R.F.I

Rev: Amendment:

ISSUED FOR APPROVAL

Copyright ©

Client: S. BRIEN

Project: AS CONSTRUCTED STUDIO Address:924 DEDDINGTON ROAD,

Date Drawn: 13.03.25 **DEDDINGTON TAS 7212**

PLUS BUILDING DESIGN
PROJECT MANAGEMENT
GIVIL/STRUCTURAL ENGIS

ENGINEERING

Drawing No: 2025-37 A11/A11

Drawn: J. Chin

Checked: R . Hall

25.09.25 J.C Accredited Building Designer Drawi Designer Name: J.Pfeiffer Accreditation No: CC2211T

Rev С